



BLOCK ONE, CARPENTER

ADDITION NO. 2

BLOCK ONE. CARPENTER ADDITION NO. 2

WIDE SEGMENT


CARPENTER

ADDITION NO. 2

DEDICATED AS

ACCESS EASEMENT

OF LOT 2 BLOCK ONE,

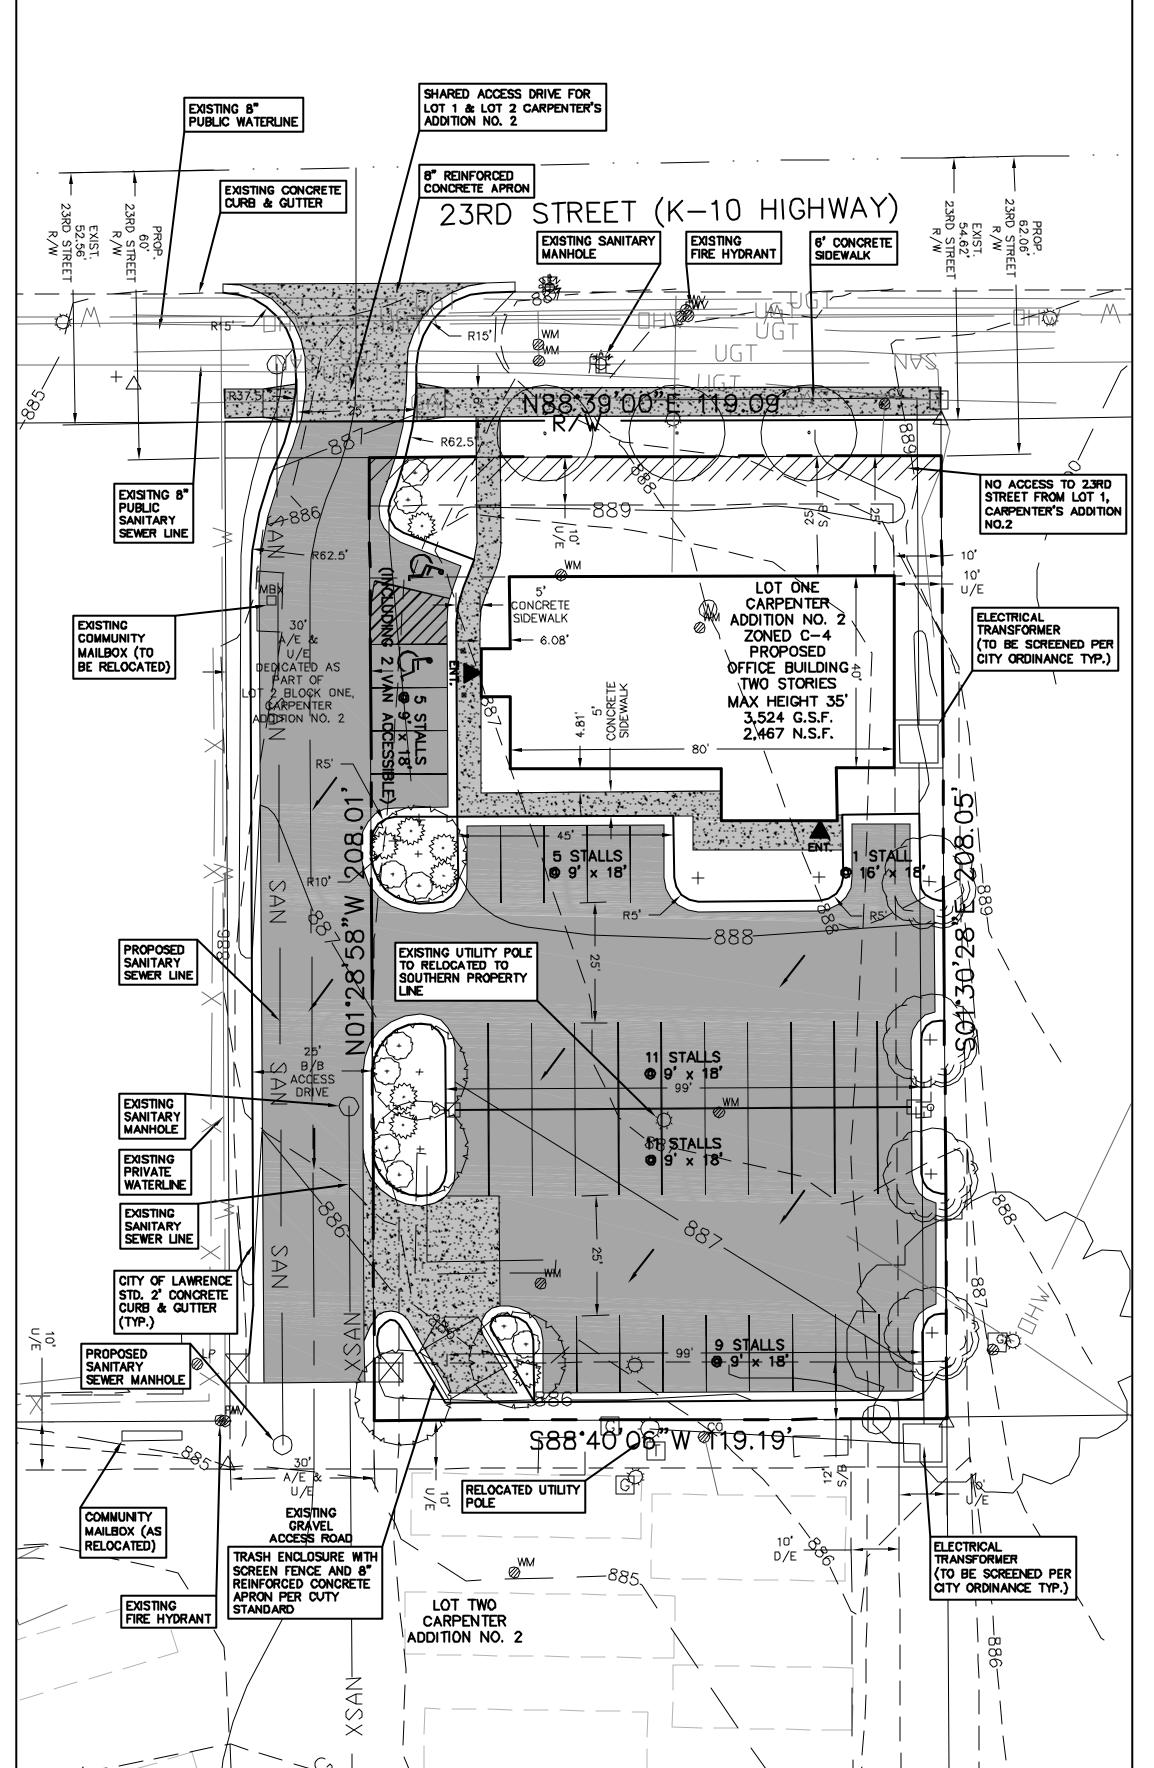

SITE SUMMARY

THE DATA WITHIN THE FOLLOWING TABLE REPRESENTS THE PROPOSED TOTAL


Lot 1	Area (Sq. Ft.)		Area (Sq. Ft.		
Existing Buildings		7,090	Proposed Buildings		3,52
Existing Pavement	(existing surface is	gravel) 0	Proposed Pavement		14,67
Existing Impervious	Subtotal:	7,090	Proposed Impervious	Subtotal:	18,19
Existing Pervious		17,694	Proposed Pervious		5,70
Property Area		24,784			23,89

INTERIOR GREENSPACE:

REQUIRED = NUMBER OF STALLS x 280 x 15% (OR .15) = REQUIRED INTERIOR GREENSPACE


42 x 280 X .15 = 1,764 S.F. OF INTERIOR GREENSPACE

PROVIDED = 2,391 S.F. INTERIOR GREENSPACE PROVIDED

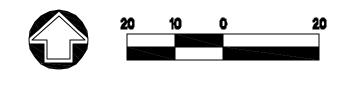

NORTH SCALE: 1" = 20'

LOCATION MAP

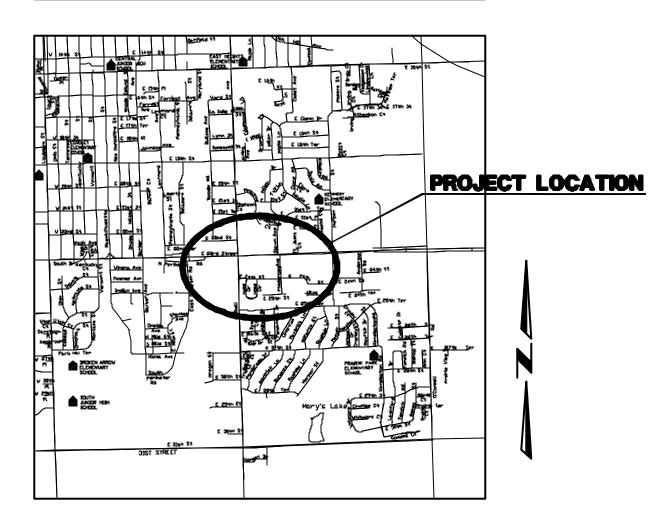

LEGAL DESCRIPTION

LOT ONE, BLOCK ONE CARPENTER ADDITION NO. 2

GENERAL NOTES

- EXISTING ZONING: C-4
- CURRENT USE: MOBILE HOME PARK
- TOPOGRAPHIC INFORMATION OBTAINED FROM AN AERIAL SURVEY
- PERFORMED BY M.J. HARDEN ASSOCIATES, 2002. BUILDING INFORMATION:
 - PROPOSED: 3,524 G.S.F. 2,467 N.S.F.
- 5. PARKING INFORMATION: C-4 PROFFESSIONAL OFFICES, USE GROUP 13 REQUIRED: 1 STALL PER 300 N.S.F.
 - 8 STALLS REQUIRED
 DED: 42 SPACES (INCL 2 ACCESSIBLE)
- MEET CITY OF LAWRENCE STANDARDS. ASPHALT PAVEMENT SHALL MEET OR EXCEED CITY OF LAWRENCE MINIMUM STANDARDS.
- PROPOSED CONCRETE PAVEMENT TO BE 8" PORTLAND REINFORCED CONCRETE ON COMPACTED SUBGRADE UNI ESS OTHERWISE SHOWN

PROPOSED DRIVE AND PARKING AREAS TO HAVE CONCRETE 24" CURB AND GUTTER TO


- 3. WALL MOUNTED LIGHTING SHALL BE LOCATED AT BUILDING ENTRANCES. ALL LIGHTING
- 9. THE CITY OF LAWRENCE SHALL NOT BE RESPONSIBLE FOR DAMAGE TO PAVEMENT DUE
- TO THE WEIGHT OF REFUSE VEHICLES.

 10. THIS SITE PLAN HAS BEEN DESIGNED TO COMPLY WITH THE PROVISIONS OF THE
- AMERICANS WITH DISABILITIES ACT ACCESSIBILITY GUIDELINES (ADAAG) FOR BUILDING AND FACILITIES. APPENDIX A TO 28 CFR PART 36.
- 11. ACCESSIBLE SPACES ARE TO BE SIGNED AND STENCILED PER ORDINANCE 20-1205-F.
 12. ALL TRAFFIC CONTROL SIGNS PLACED ON PRIVATE PROPERTY OPEN TO THE PUBLIC SHALL COMPLY WITH THE "MANUAL OF UNIFORM TRAFFIC CONTROL DEVICES"

LANDSCAPE SCHEDULE PHASING PLAN

SYM.	QUAN. NAME		SIZE	COND.			
TREES							
\odot	3	AUTUNN PURPLE ASH Froxinus americana 'Autumn Purple'	2" - 2-1/2" CAL.	B & B			
+	4	RED NAPLE Aber rubrum 'Red Sunset'	2" - 2-1/2" GAL	B&B			
\odot	5	EASTERN REDBUD Certis conodensis	1-1/2" - 2" CAL	B&B Multi-Sten			
SHRUBS							
+	10	DWARF BURNING BUSH Euonymus alata "Compacta"	24"-30" HT.	CONT.			
* + ** + **	8	ANDORRA JUNIPER Juniperus harizankalis	18"-24" SPR.	CONT.			

- BARK CHIP MULCH TO BE INSTALLED IN AREAS WITHIN PLANTING BEDS
- TURF AREAS TO BE SEEDED WITH K-31 FESCUE BLEND OR SODDED PER DIRECTION OF OWNER

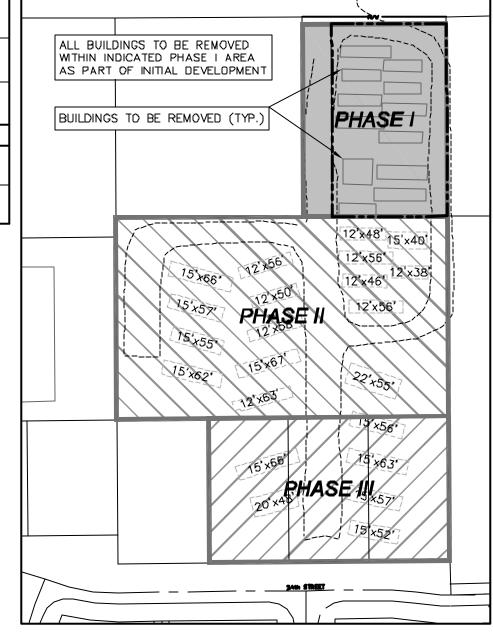

BENCHMARKS:

1. "

CHISELED S.W. CORNER CURB INLET ON.E.

CORNER OF 25TH TERRACE AND HASKELL AV.

ELEV. = 876.11

2. "

CHISELED N. END OF RETAINING WALL JUST S. OF DRIVE INTO TOLAR CABINETS. ELEV. = 879.01



SITE PLAN MIDYETT OFFICE



Landplan Engineerin

©Landplan Engineering, P.A. 2004. This drawing is copyrighted by Landplan Engineering, P.A. This drawing may not be phatagraphed, traced, or copied in any

phatagraphied, traced, or copied in any manner with out the written permission of Landplan Engineering, P.A.

REVISIONS

12.29.04 per city comments

D2.03.05 revised buildling layout

DATE: 11.16.04
PROJECT NO.: 2004,667.12
DRAWING ID: 04667-pp-glo
DESIGNED BY: CLM
DRAWN BY: BRM
CHECKED BY: CLM

SHEET NO.

1 OF 1 SHEE